


This drawing is copyright and the property of DMWA Ltd. It may not be copied reproduced or altered in any way without their written authority. Do not scale from this drawing, work to figured dimensions. All dimensions to be checked on site and any discrepancies reported to the Architect immediately. All structural and specialist elements/components/details, including glazing, are to be approved by the Structural Engineer or Specialist

Common/everyday hazards associated with Building Products and Construction processes are not listed below and will be assumed to be controlled by the <u>Principal Contractor</u> following good safety, management and site practice procedures.

The proposed works are designed on a well rine proposed works are designed on a well established method of construction, which can be carried out by a competent contractor. However, should the contractor find any area of concern he must inform the designer immediately in order that


building footprint App 7-2021-11229-O

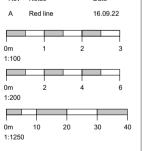


Replacement Cafe Beach House Café The Spit Mudeford BH6 4EN


Drawing Title: Location Plan & Existing Site Plan

As Indicated @ A3

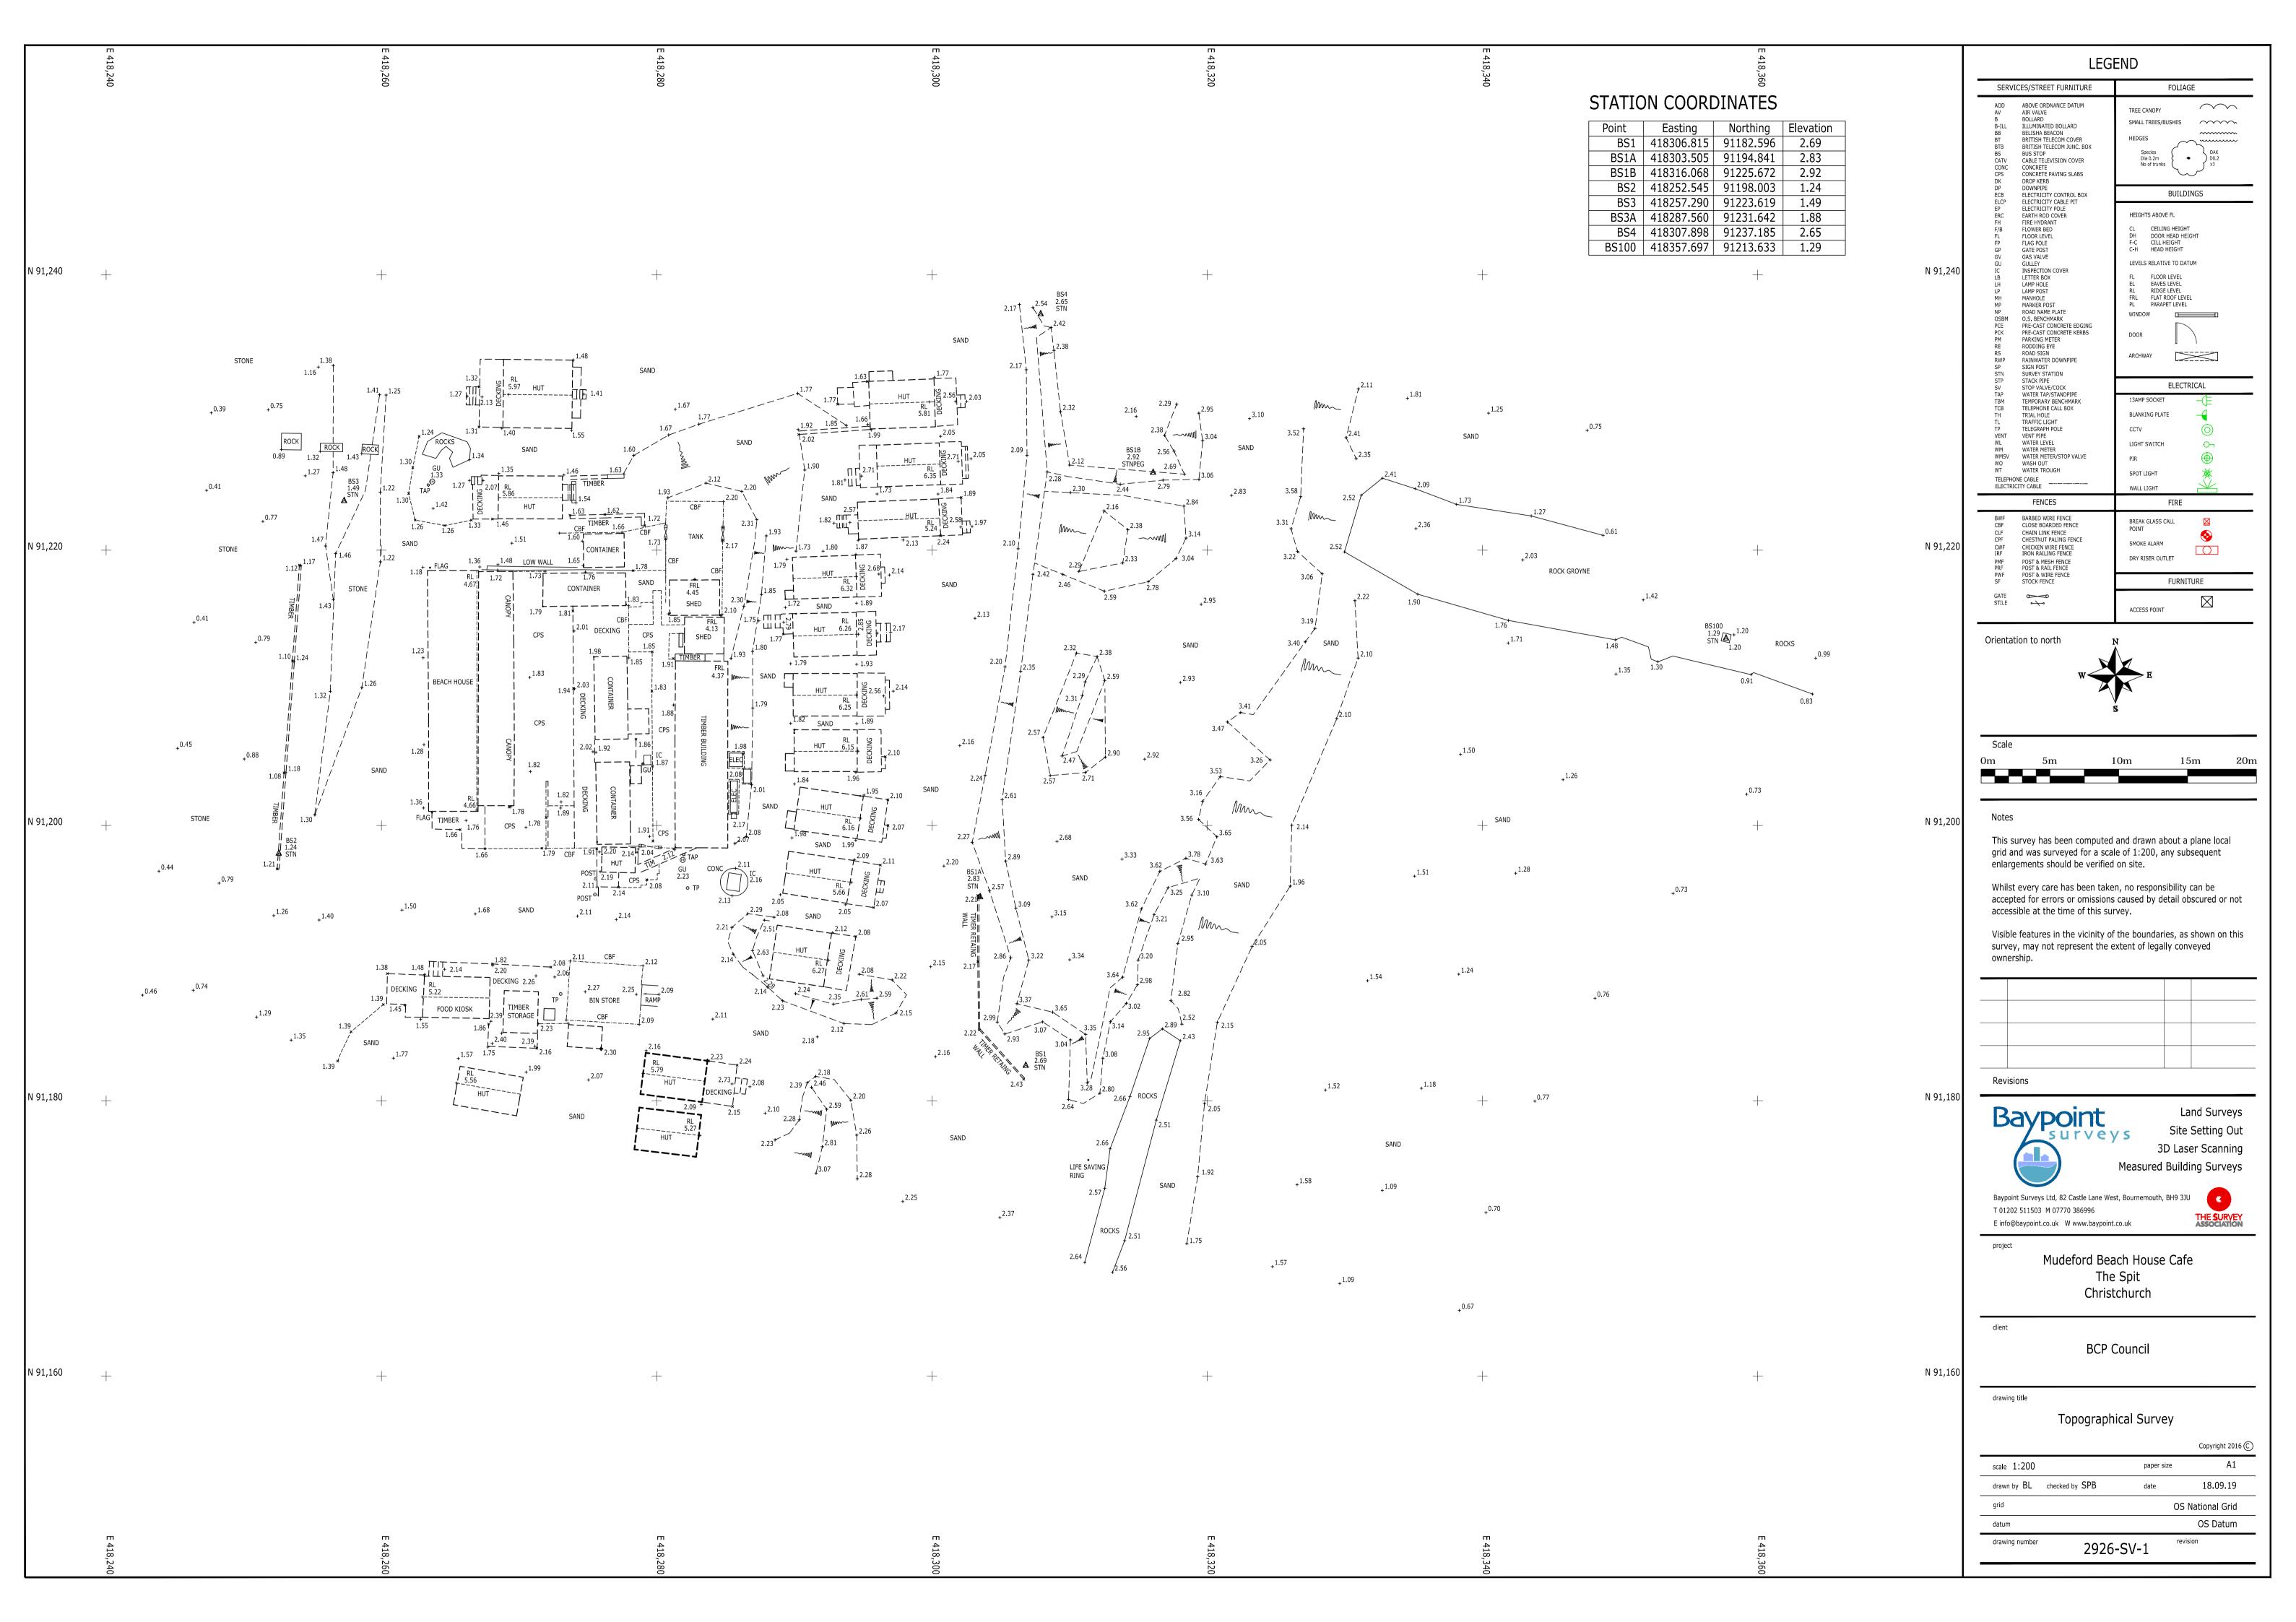

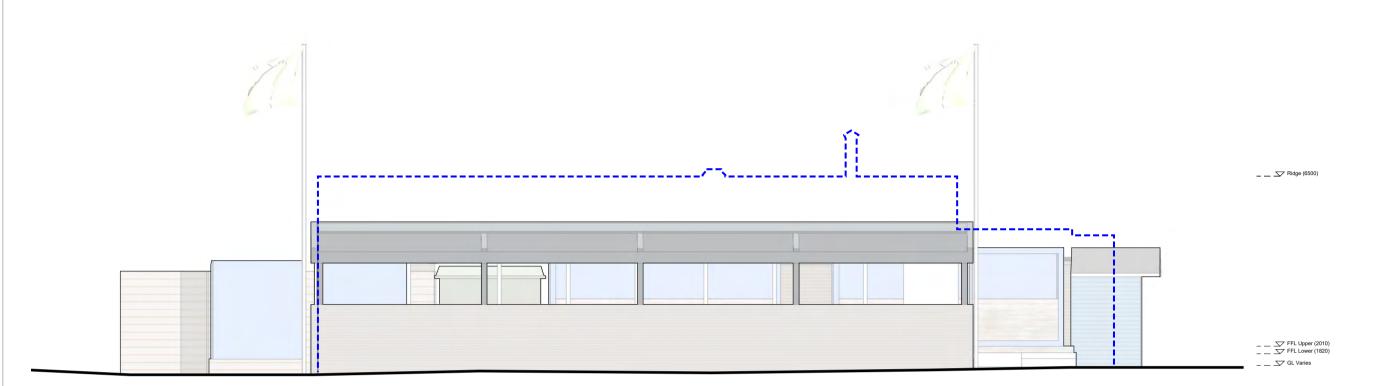

Existing West Elevation _ _ 🗢 🗸 000 1:100

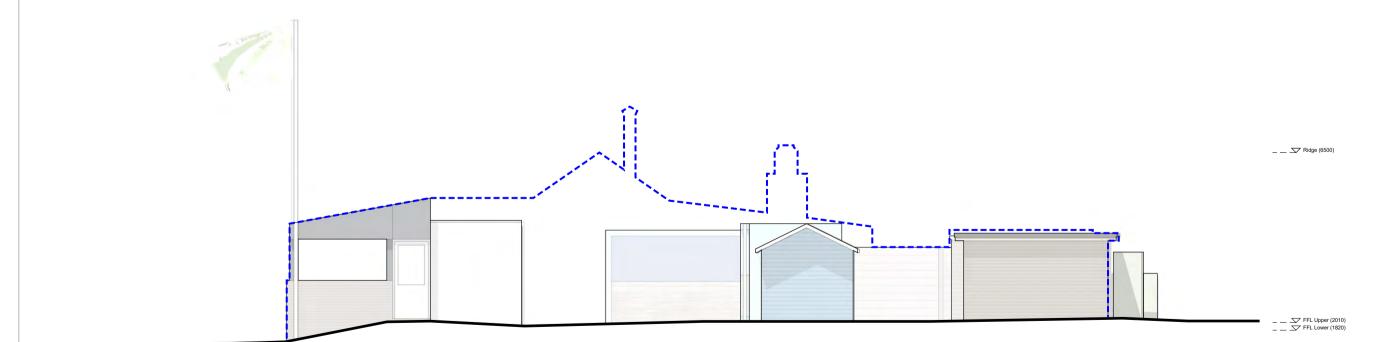

Existing South Elevation

1:100 _ _ 🗢 🗸 000

PLANNING

This drawing is copyright and the property of DMWA Ltd. It may not be copied reproduced or altered in any way without their written authority. Do not scale from this drawing, work to figured dimensions. All dimensions to be checked on site and any discrepancies reported to the Architect immediately. All structural and specialist elements/components/details, including glazing, are to be approved by the Structural Engineer or Specialist Contractor.

DESIGNERS RISK ASSESSMENT: HEALTH AND SAFETY THE CONSTRUCTION (DESIGN AND MANAGEMENT) REGULATIONS 2007


Building Products and Construction Execution Hazards

Common/everyday hazards associated with Building Products and Construction processes are not listed below and will be assumed to be controlled by the <u>Principal Contractor</u> following good safety, management and site practice procedures.

The proposed works are designed on a well established method of construction, which can be carried out by a competent contractor. However, should the contractor find any area of concern he must inform the designer immediately in order that appropriate action can be taken.

THESE DRAWINGS ARE FOR PLANNING PURPOSES ONLY AND ARE NOT FOR CONSTRUCTION

Pre-fire / Approved building profile
App 7-2021-11229-0

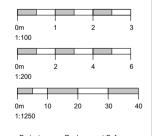

Replacement Cafe Beach House Café The Spit Mudeford BH6 4EN

K Slater Client:

Drawing Title: Existing Elevations Job No: 201004

AR/RM


28.02.22 Date:

As Indicated @ A3 Scale:


Drawing No: PL02

Drawn:

architects

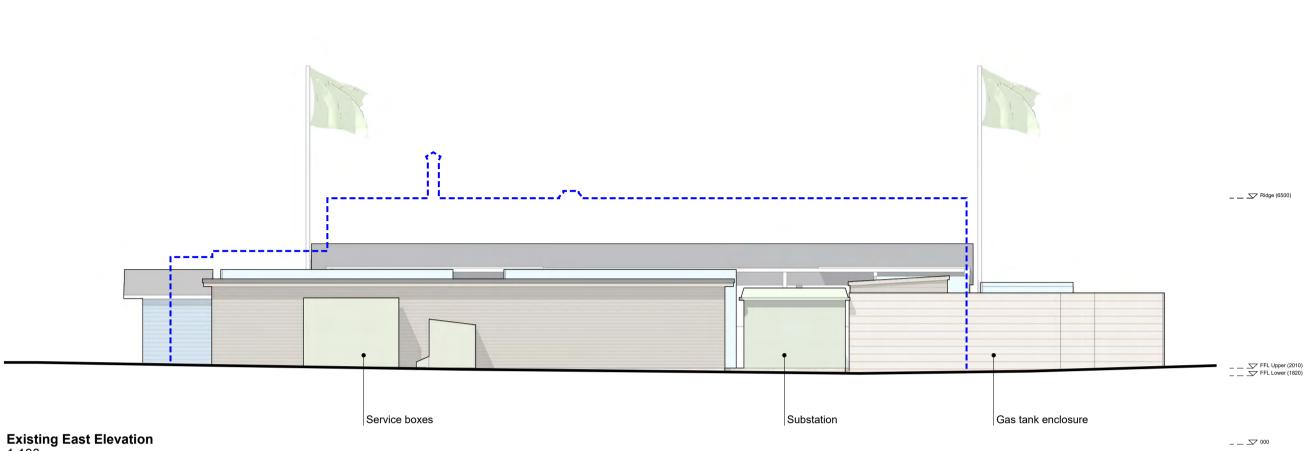

1:100

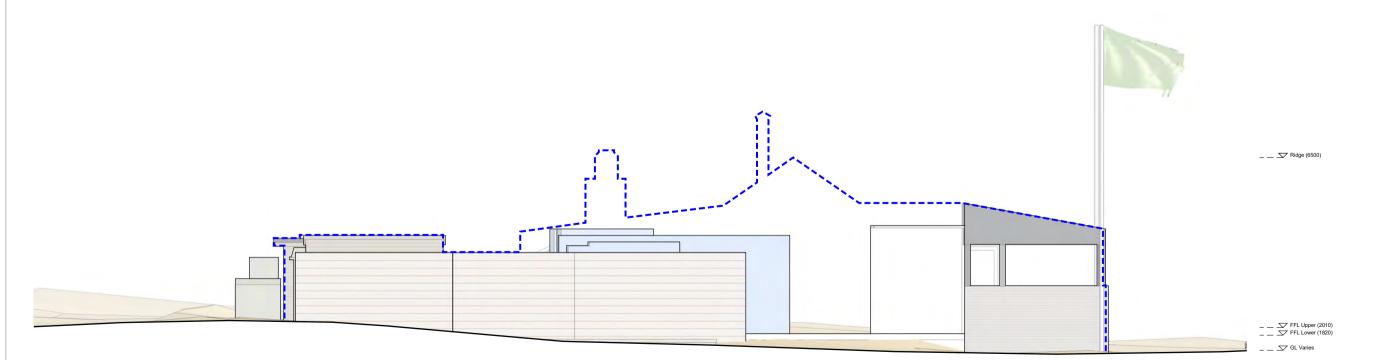

Existing North Elevation

1:100

PLANNING

This drawing is copyright and the property of DMWA Ltd. It may not be copied reproduced or altered in any way without their written authority. Do not scale from this drawing, work to figured dimensions. All dimensions to be checked on site and any discrepancies reported to the Architect immediately. All structural and specialist elements/components/details, including glazing, are to be approved by the Structural Engineer or Specialist

DESIGNERS RISK ASSESSMENT: HEALTH AND SAFETY THE CONSTRUCTION (DESIGN AND MANAGEMENT) REGULATIONS 2007


Building Products and Construction Execution Hazards

Common/everyday hazards associated with Building Products and Construction processes are not listed below and will be assumed to be controlled by the <u>Principal Contractor</u> following good safety, management and site practice procedures.

The proposed works are designed on a well established method of construction, which can be carried out by a competent contractor. However, should the contractor find any area of concern he must inform the designer immediately in order that appropriate action can be taken.

THESE DRAWINGS ARE FOR PLANNING PURPOSES ONLY AND ARE NOT FOR CONSTRUCTION

Pre-fire / Approved building profile
App 7-2021-11229-0

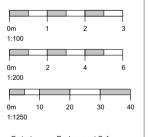

Replacement Cafe Beach House Café The Spit Mudeford BH6 4EN

K Slater Client:

Drawing Title: Existing Elevations


Job No: 201004 Drawn: AR/RM 28.02.22 Date:

As Indicated @ A3 Drawing No: PL03


Scale:

architects

_ _ 🗢 🗸 000

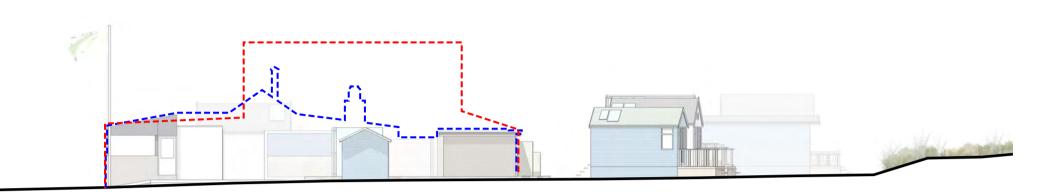

Existing South Contextual Elevation 1:200

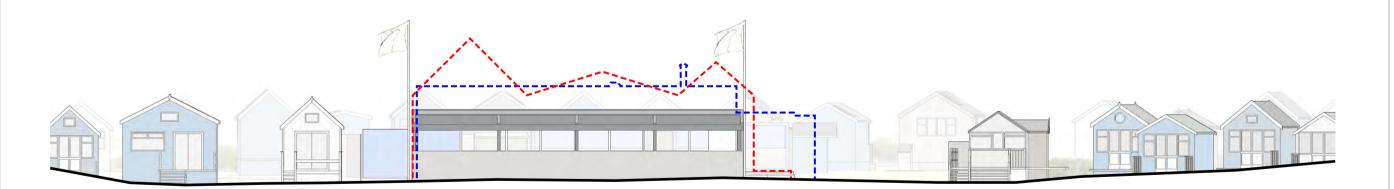

Existing West Contextual Elevation 1:200

PLANNING

This drawing is copyright and the property of DMWA Ltd. It may not be copied reproduced or altered in any way without their written authority. Do not scale from this drawing, work to figured dimensions. All dimensions to be checked on site and any discrepancies reported to the Architect immediately. All structural and specialist elements/components/details, including glazing, are to be approved by the Structural Engineer or Specialist

DESIGNERS RISK ASSESSMENT: HEALTH AND SAFETY THE CONSTRUCTION (DESIGN AND MANAGEMENT) REGULATIONS 2007

Building Products and Construction Execution Hazards


Common/everyday hazards associated with Building Products and Construction processes are not listed below and will be assumed to be controlled by the <u>Principal Contractor</u> following good safety, management and site practice procedures.

The proposed works are designed on a well established method of construction, which can be carried out by a competent contractor. However, should the contractor find any area of concern he must inform the designer immediately in order that appropriate action can be taken.

THESE DRAWINGS ARE FOR PLANNING PURPOSES ONLY AND ARE NOT FOR CONSTRUCTION

Pre-fire / Approved building profile
App 7-2021-11229-0

Profile of Refused Structure App 7-2020-11229-M

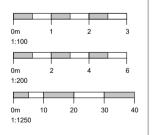

Replacement Cafe Beach House Café The Spit Mudeford BH6 4EN

K Slater Drawing Title: Existing Context Elevations

Job No: 201004 Drawn: AR/RM 28.02.22 Date:

As Indicated @ A3

Drawing No: PL04

architects

1:200

PLANNING

This drawing is copyright and the property of DMWA Ltd. It may not be copied reproduced or altered in any way without their written authority. Do not scale from this drawing, work to figured dimensions. All dimensions to be checked on site and any discrepancies reported to the Architect immediately. All structural and specialist elements/components/details, including glazing, are to be approved by the Structural Engineer or Specialist Contractor.

DESIGNERS RISK ASSESSMENT: HEALTH AND SAFETY THE CONSTRUCTION (DESIGN AND MANAGEMENT) REGULATIONS 2007

Building Products and Construction Execution Hazards

Common/everyday hazards associated with Building Products and Construction processes are not listed below and will be assumed to be controlled by the <u>Principal Contractor</u> following good safety, management and site practice procedures.

The proposed works are designed on a well established method of construction, which can be carried out by a competent contractor. However, should the contractor find any area of concern he must inform the designer immediately in order that appropriate action can be taken.

THESE DRAWINGS ARE FOR PLANNING PURPOSES ONLY AND ARE NOT FOR CONSTRUCTION

Rev Notes

0m 1 2 3 1:100 0m 2 4 6 1:200

> ject: Replacement C Beach House C The Spit Mudeford BH6 4FN

Client: K Slater

Drawing Title: Proposed Site / Roof Plan

 Job No:
 201004

 Drawn:
 AR/RM

 Date:
 28.02.22

Scale: As Indicated @ A3

Drawing No: PL05
Rev: A

DMW architects

Key Design Principles

A simple and recognisable form, modest in scale, presenting a clear and uncluttered building for all users to enjoy

*Accessible for all

*Building with a clear identity and sense of place

*Recognisable form harmonises with setting and character of site

*Unified and uncluttered visual appearance

*Facing materials will be robust and low maintenance

*Lightweight and modular construction

*Minimise physical and environmental impact

*Harness solar energy and natural daylight

*Enhanced privacy and outlook for nearby beach hut residents

*Perimeter dune grasses to promote stability and living rood to encourage wildlife

*Positive asset for all visitors

Typical Construction

A modular building from pre made components, constructed off site to minimise time, noise, cost and construction traffic

*Pre cast concrete piles with modular galvanised steel frame set over

*Pre cast concrete floor planks to support walls

*SIPS modular wall and roof panels

Proposed Floor Plan

1:100

*Non combustible, pre weathered materials

*Robust roofing material and rainwater goods



PLANNING

This drawing is copyright and the property

reproduced or altered in any way without

their written authority. Do not scale from this drawing, work to figured dimensions.

All dimensions to be checked on site and any discrepancies reported to the Architect

immediately. All structural and specialist

elements/components/details, including

glazing, are to be approved by the

Structural Engineer or Specialist

DESIGNERS RISK ASSESSMENT: HEALTH AND SAFETY THE CONSTRUCTION (DESIGN AND MANAGEMENT) REGULATIONS 2007

Building Products and Construction Execution Hazards

Commonleveryday hazards associated with Building Products and Construction processes are not listed below and will be assumed to be controlled by the Principal Contractor following good safety, management and site practice procedures.

The proposed works are designed on a well established method of construction, which can be carried out by a competent contractor. However, should the contractor find any area of concern he must inform the designer immediately in order that

THESE DRAWINGS ARE FOR PLANNING PURPOSES ONLY AND ARE NOT FOR CONSTRUCTION

appropriate action can be taken.

1:200

Job No:

Drawn:

Date:

Scale:

Replacement Cafe Beach House Café The Spit Mudeford

BH6 4FN

K Slater

201004

AR/RM

28.02.22

Drawing No: PL06

Α


architects

01202 884024 www.dmwa.co.uk

As Indicated @ A3

Drawing Title: Proposed Floor Plan

of DMWA Ltd. It may not be copied

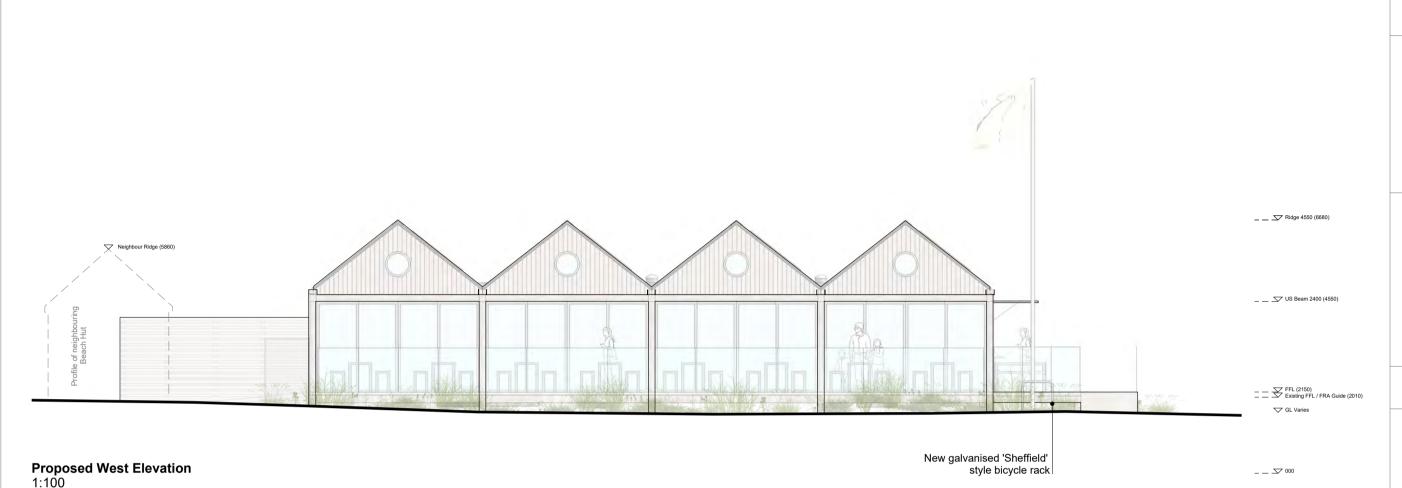

(01) (03) Service (02) (04) (05) (06) (07) (08) (09) Hatch _ _ Nidge 4550 (6680) _ _ _ US Beam 2400 (4550) Profile of neighbouring _ _ FFL (2150)
Existing FFL / FRA Guide (2010) New galvanised 'Sheffield' 10 style bicycle rack **Proposed South Elevation**

1:100

PLANNING

This drawing is copyright and the property of DMWA Ltd. It may not be copied reproduced or altered in any way without their written authority. Do not scale from this drawing, work to figured dimensions. All dimensions to be checked on site and any discrepancies reported to the Architect immediately. All structural and specialist elements/components/details, including glazing, are to be approved by the Structural Engineer or Specialist

DESIGNERS RISK ASSESSMENT: HEALTH AND SAFETY THE CONSTRUCTION (DESIGN AND MANAGEMENT) REGULATIONS 2007

Building Products and Construction Execution Hazards

Common/everyday hazards associated with Building Products and Construction processes are not listed below and will be assumed to be controlled by the <u>Principal Contractor</u> following good safety, management and site practice procedures.

The proposed works are designed on a well established method of construction, which can be carried out by a competent contractor. However, should the contractor find any area of concern he must inform the designer immediately in order that appropriate action can be taken.


THESE DRAWINGS ARE FOR PLANNING PURPOSES ONLY AND ARE NOT FOR CONSTRUCTION

Materials

- 01 PPC aluminium fixed angle privacy fins mid grey colour
- 02 Inset PV panels matt finish
- 03 PPC aluminium rainwater goods mid grey colour
- 04 Fibre cementitious cladding strips silver oak colour
- 05 PPC aluminium glazing frames mid grey colour
- 06 Corrugated fibre cementitious roof panels anthracite colour
- 07 Fibre cementitious cladding strips silver oak colour
- 08 Green roof | Sea hardened durable sedum mix in llightweight growing medium over EPDM roof
- 09 Flat roof sun tunnel
- 10 Frameless glass balustrade

Rev Notes Date

A Bike rack relocated 16.09.22

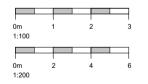

roject: Replacement Cafe Beach House Café The Spit Mudeford BH6 4EN

Client: K Slater

Drawing Title: Proposed West & South Elevations

Job No: 201004

Drawn: AR/RM

Date: 28.02.22

Date: 28.02.22

Scale: As Indicated @ A3

Drawing No: PL07
Rev: A

_ _ 🗢 🕏 000

DMW architects

This drawing is copyright and the property of DMWA Ltd. It may not be copied reproduced or altered in any way without their written authority. Do not scale from this drawing, work to figured dimensions. All dimensions to be checked on site and any discrepancies reported to the Architect immediately. All structural and specialist elements/components/details, including glazing, are to be approved by the Structural Engineer or Specialist Contractor.

DESIGNERS RISK ASSESSMENT: HEALTH AND SAFETY THE CONSTRUCTION (DESIGN AND MANAGEMENT) REGULATIONS 2007


Building Products and Construction Execution Hazards

Common/everyday hazards associated with Building Products and Construction processes are not listed below and will be assumed to be controlled by the <u>Principal Contractor</u> following good safety, management and site practice procedures.

The proposed works are designed on a well established method of construction, which can be carried out by a competent contractor. However, should the contractor find any area of concern he must inform the designer immediately in order that appropriate action can be taken.

THESE DRAWINGS ARE FOR PLANNING PURPOSES ONLY AND ARE NOT FOR CONSTRUCTION

Rev Notes I

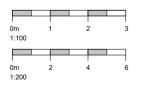

Project: Replacement Cafe Beach House Café The Spit Mudeford BH6 4EN

lient: K Slater

Drawing Title: Proposed East & North Elevations

 Job No:
 201004

 Drawn:
 AR/RM

 Date:
 28.02.22

Date: 28.02.22
Scale: As Indicated @ A3

Drawing No: PL08
Rev: A

DMW architects

This drawing is copyright and the property of DMWA Ltd. It may not be copied reproduced or altered in any way without their written authority. Do not scale from this drawing, work to figured dimensions. All dimensions to be checked on site and any discrepancies reported to the Architect immediately. All structural and specialist elements/components/details, including glazing, are to be approved by the Structural Engineer or Specialist Contractor.

DESIGNERS RISK ASSESSMENT: HEALTH AND SAFETY THE CONSTRUCTION (DESIGN AND MANAGEMENT) REGULATIONS 2007

Building Products and Construction Execution Hazards

Common/everyday hazards associated with Building Products and Construction processes are not listed below and will be assumed to be controlled by the <u>Principal Contractor</u> following good safety, management and site practice procedures.

The proposed works are designed on a well established method of construction, which can be carried out by a competent contractor. However, should the contractor find any area of concern he must inform the designer immediately in order that appropriate action can be taken.

THESE DRAWINGS ARE FOR PLANNING PURPOSES ONLY AND ARE NOT FOR CONSTRUCTION

Rev Notes

0m 1 2 3 1:100 0m 2 4 6 1:200

A AOD to Dimensions 23.11.22

Date

oject:

Mudeford BH6 4EN

Client: K Slater

Drawing Title: Proposed Sections


Job No: 201004

Drawn: AR/RM
Date: 28.02.22
Scale: As Indicated @ A3


Drawing No: PL09

DMW architects

46a East Street, Wimborne, BH21 1DX

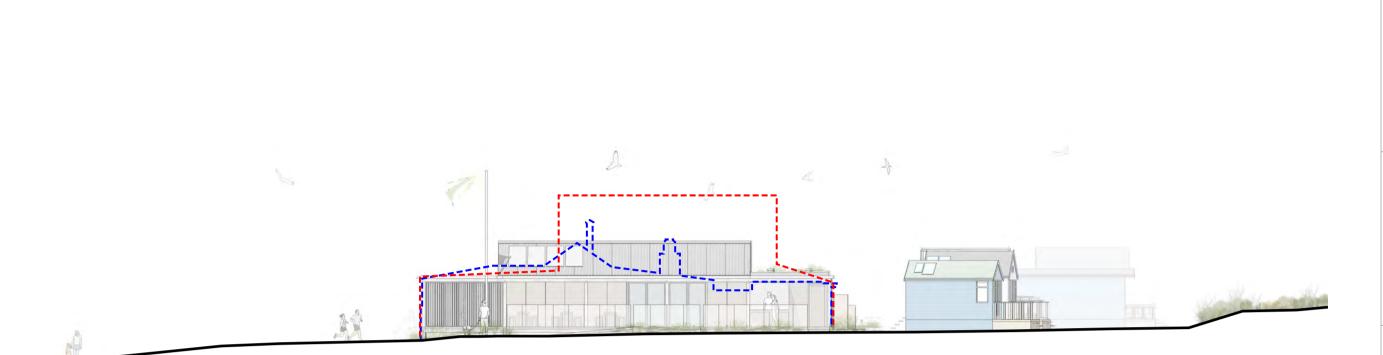

Proposed South Contextual Elevation 1:200

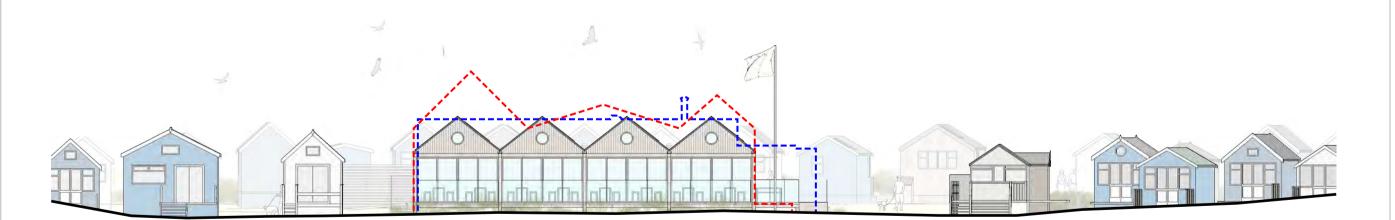

Proposed West Contextual Elevation 1:200

PLANNING

This drawing is copyright and the property of DMWA Ltd. It may not be copied reproduced or altered in any way without their written authority. Do not scale from this drawing, work to figured dimensions. All dimensions to be checked on site and any discrepancies reported to the Architect immediately. All structural and specialist elements/components/details, including glazing, are to be approved by the Structural Engineer or Specialist

DESIGNERS RISK ASSESSMENT: HEALTH AND SAFETY THE CONSTRUCTION (DESIGN AND MANAGEMENT) REGULATIONS 2007

Building Products and Construction Execution Hazards


Common/everyday hazards associated with Building Products and Construction processes are not listed below and will be assumed to be controlled by the <u>Principal Contractor</u> following good safety, management and site practice procedures.

The proposed works are designed on a well established method of construction, which can be carried out by a competent contractor. However, should the contractor find any area of concern he must inform the designer immediately in order that appropriate action can be taken.

THESE DRAWINGS ARE FOR PLANNING PURPOSES ONLY AND ARE NOT FOR CONSTRUCTION

Pre-fire / Approved building profile
App 7-2021-11229-0

Profile of Refused Structure App 7-2020-11229-M

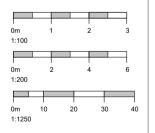

Replacement Cafe Beach House Café The Spit Mudeford BH6 4EN

K Slater

Job No: 201004 Drawn: AR/RM 28.02.22 Date:

As Indicated @ A3

Drawing No: PL10

architects

This drawing is copyright and the property of DMWA Ltd. It may not be copied reproduced or altered in any way without their written authority. Do not scale from this drawing, work to figured dimensions. All dimensions to be checked on site and any discrepancies reported to the Architect immediately. All structural and specialist elements/components/details, including glazing, are to be approved by the Structural Engineer or Specialist Contractor.


DESIGNERS RISK ASSESSMENT: HEALTH AND SAFETY THE CONSTRUCTION (DESIGN AND MANAGEMENT) REGULATIONS 2007

Building Products and Construction Execution Hazards

Common/everyday hazards associated with Building Products and Construction processes are not listed below and will be assumed to be controlled by the <u>Principal Contractor</u> following good safety, management and site practice procedures.

The proposed works are designed on a well established method of construction, which can be carried out by a competent contractor. However, should the contractor find any area of concern he must inform the designer immediately in order that appropriate action can be taken.

THESE DRAWINGS ARE FOR PLANNING PURPOSES ONLY AND ARE NOT FOR CONSTRUCTION

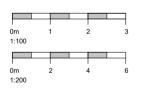

BH6 4FN

K Slater Client:

Drawing Title: Proposed Floor Areas

Job No: 201004 AR/RM Drawn: Date: 16.09.22

As Indicated @ A3

Drawing No: PL11



1:100



This drawing is copyright and the property of DMWA Ltd. It may not be copied reproduced or altered in any way without their written authority. Do not scale from this drawing, work to figured dimensions. All dimensions to be checked on site and any discrepancies reported to the Architect immediately. All structural and specialist elements/components/details, including glazing, are to be approved by the Structural Engineer or Specialist Contractor.

DESIGNERS RISK ASSESSMENT: HEALTH AND SAFETY THE CONSTRUCTION (DESIGN AND MANAGEMENT) REGULATIONS 2007

Building Products and Construction Execution Hazards

Common/everyday hazards associated with Building Products and Construction processes are not listed below and will be assumed to be controlled by the <u>Principal Contractor</u> following good safety, management and site practice procedures.

The proposed works are designed on a well established method of construction, which can be carried out by a competent contractor. However, should the contractor find any area of concern he must inform the designer immediately in order that appropriate action can be taken.

THESE DRAWINGS ARE FOR PLANNING PURPOSES ONLY AND ARE NOT FOR CONSTRUCTION

0m 1:200

Replacement Cafe Beach House Café The Spit Mudeford BH6 4EN

K Slater Client:


Drawing Title: Like for Like Floor Areas

201004 Job No:

AR/RM Drawn: Date: 16.09.22 As Indicated @ A3 Scale:

Drawing No: PL12

architects

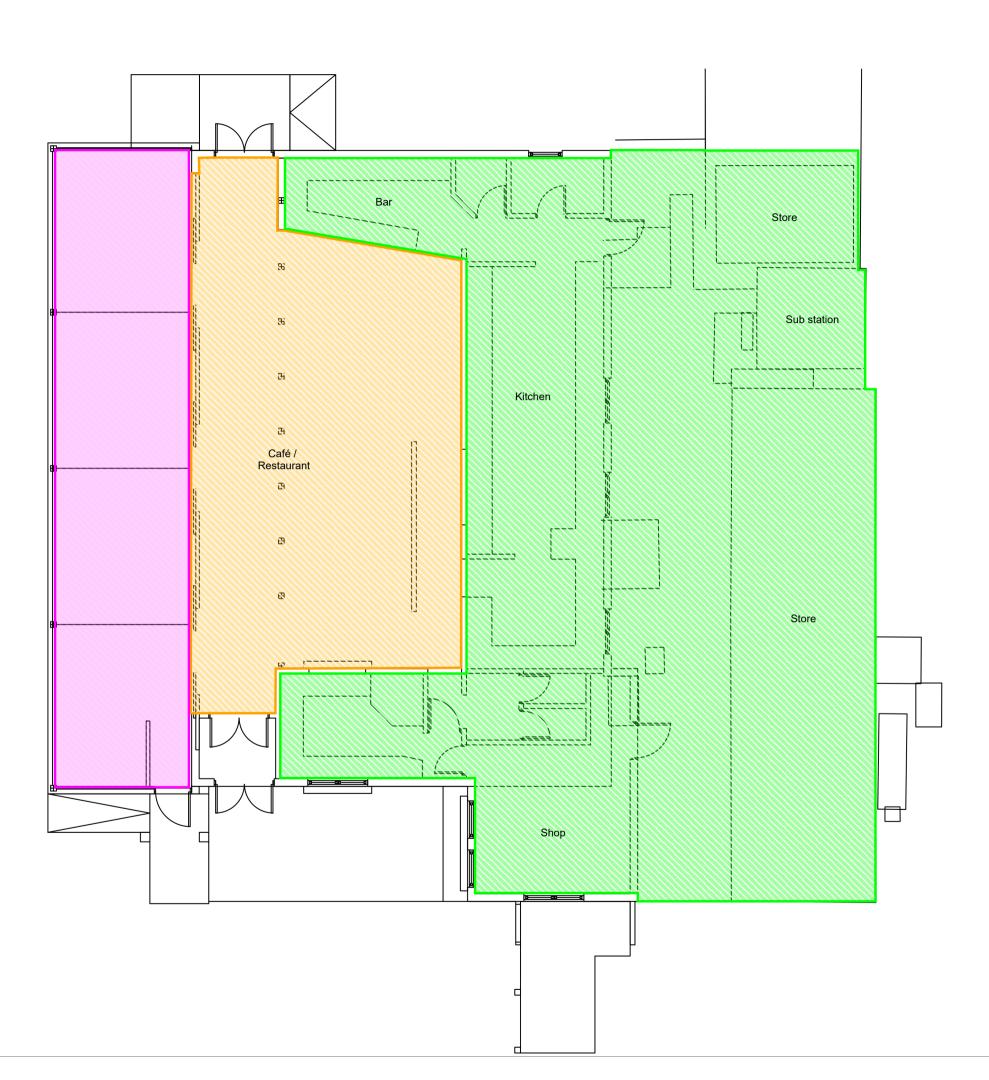

'Like for Like' Floor Plan 1:100



Internal Restaurant Floorspace

External Covered Restaurant

Services, Store, Shop & Kitchen


88m²


61m²

233m²

Total Area - 382m²

Seating Area

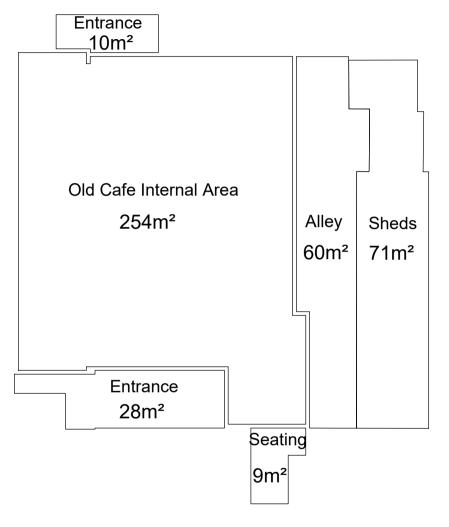

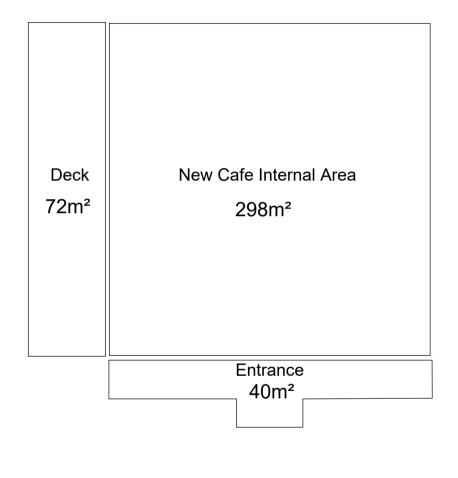

Old Cafe Floor Areas - Total 431m²

Proposed Cafe Floor Areas - Total 410m² 1/200

This drawing is copyright and the property of DMWA Ltd Chartered Architects.

It may not be copied reproduced or altered in any way without their written authority. Do not scale

Please see structural engineers specification prior to any construction works

from this drawing, work to figured dimensions.

All dimensions to be checked on site and any discrepancies reported to the Architect immediately.

PROJECT: Mudeford Beach Cafe
TITLE: Floor Area Comparison

DRAWING NO:

STATUS: Comment SCALE: 1:200 @ A4 DATE: 09.16.22

